


# SITE PLAN REVIEW SET 12-29-2017

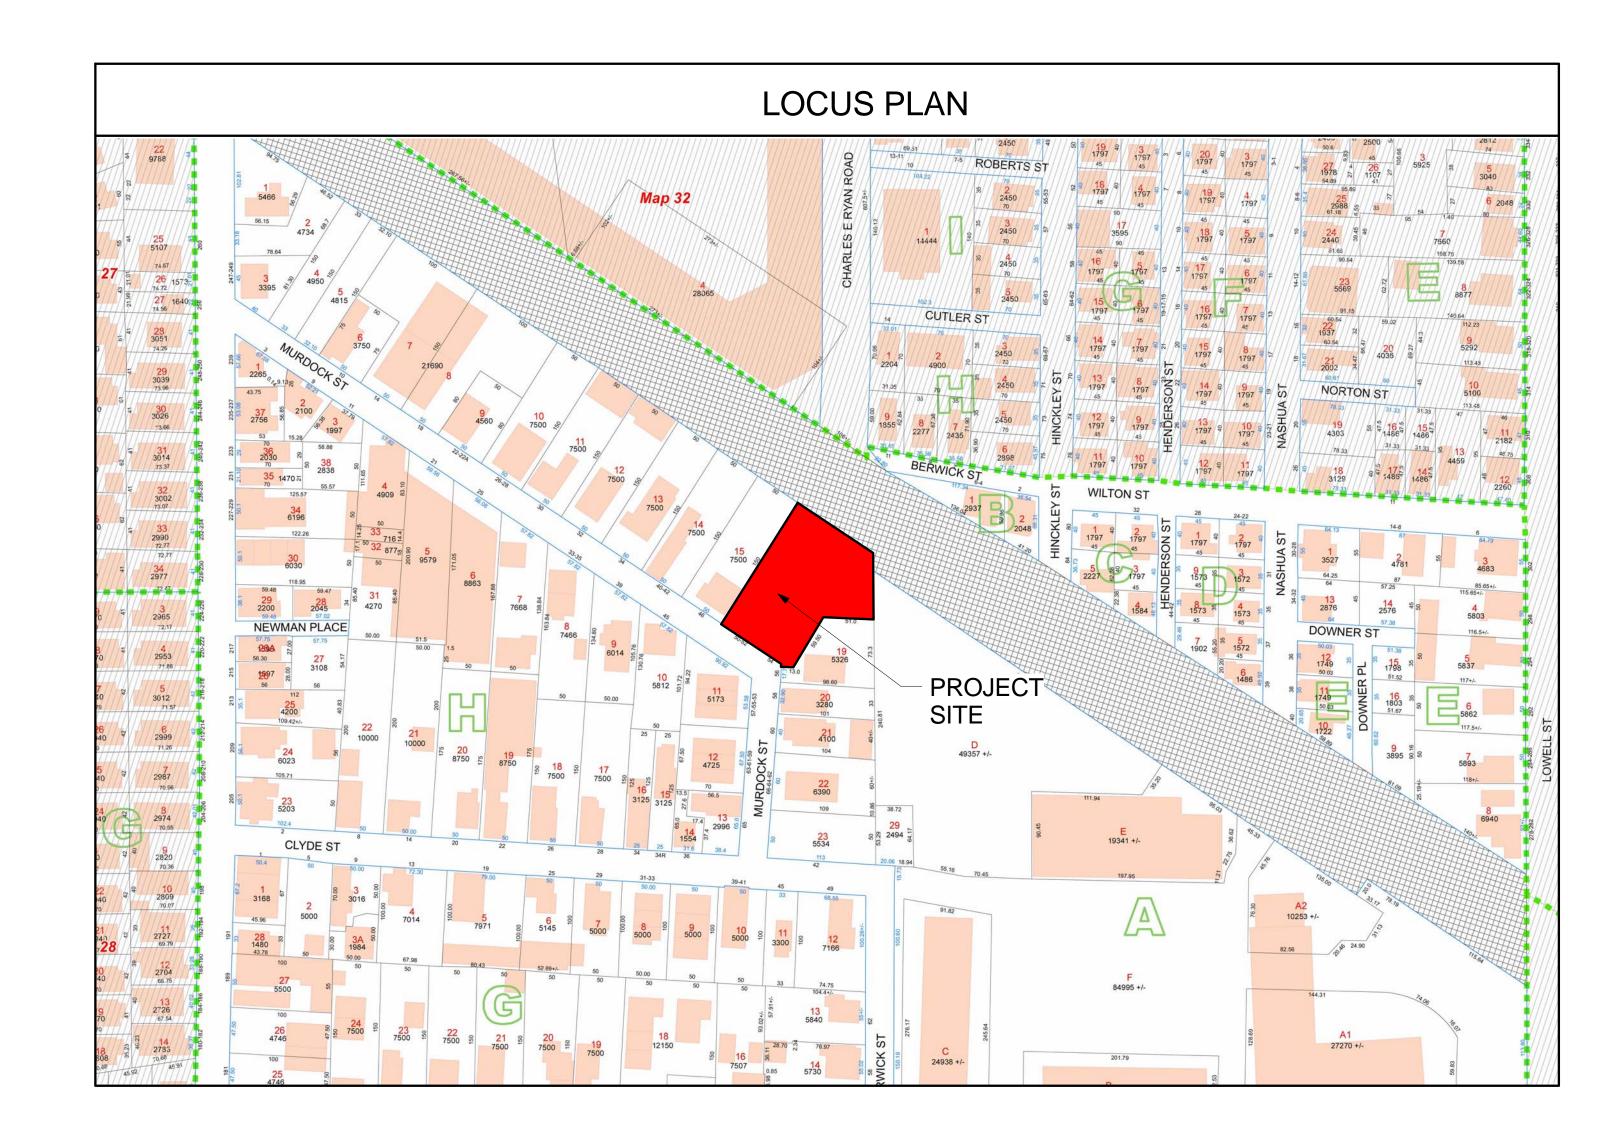

# PROJECT: MURDOCK STREET RESIDENCES

PROJECT ADDRESS: 50-54 MURDOCK STREET SOMERVILLE, MASSACHUSETTS

**ARCHITECT** KHALSA DESIGN INC. ADDRESS: 17 IVALOO STREET SOMERVILLE, MA 02143 T: 617-591-8682

<u>CLIENT</u> ROB GRIECO ADDRESS: 16 KENWOOD AVE. WILMINGTON, MA 01887 T: 781-727-5915

<u>CIVIL</u> ENGINEERING ALLIANCE, INC. ADDRESS: 194 CENTRAL ST. #2 SAUGUS, MA 01906 T: 781-231-1349

Cover Sheet

LANDSCAPE ARCHITECTS **VERDANT** ADDRESS: 318 HARVARD ST., SUITE 25 BROOKLINE, MA 02446 T: 617-735-1180

12/29/17

Sheet		Sheet Issue
Number	Sheet Name	Date

1-	Civil

A-000

C-1	Existing Conditions	12/20/17
C-2	Demolition & Erosion Plan	12/20/17
C-3	Site Plan	12/20/17
D-1 Construction Details		12/20/17
L-1	Illiustrative Landscape Plan	11/20/17

## 2- Architecture

A-020	Architectural Site Plan & Zoning Analysis	12/29/17
A-101	Basement & 1st Floor Plans	12/29/17
A-102	2nd & 3rd Floor Plans	12/29/17
A-103	Roof Plans	12/29/17
A-300	Elevations	12/29/17
A-304	Proposed Exterior Lighting Plan & Fixtures	12/29/17
AV-1	3-D Perspectives	12/29/17

PROJECT NAME

# **Murdock Street** Residences

PROJECT ADDRESS

50-54 Murdock Street, Somerville, MA

CLIENT

**Rob Grieco** 

ARCHITECT



17 IVALOO STREET SUITE 400

CONSULTANTS:

COPYRIGHT KDI © 2017 THESE DRAWINGS ARE NOW AND DO SHALL RESULT IN THE FULLEST EXTENT OF


REGISTRATION





Project nu	mber	17107
Date		12/29/2017
Drawn by		NE
Checked I	ру	JSK
Scale		1" = 1'-0'
REVISION	ONS	
No.	Description	Date
-		

Cover Sheet

Murdock Street Residences

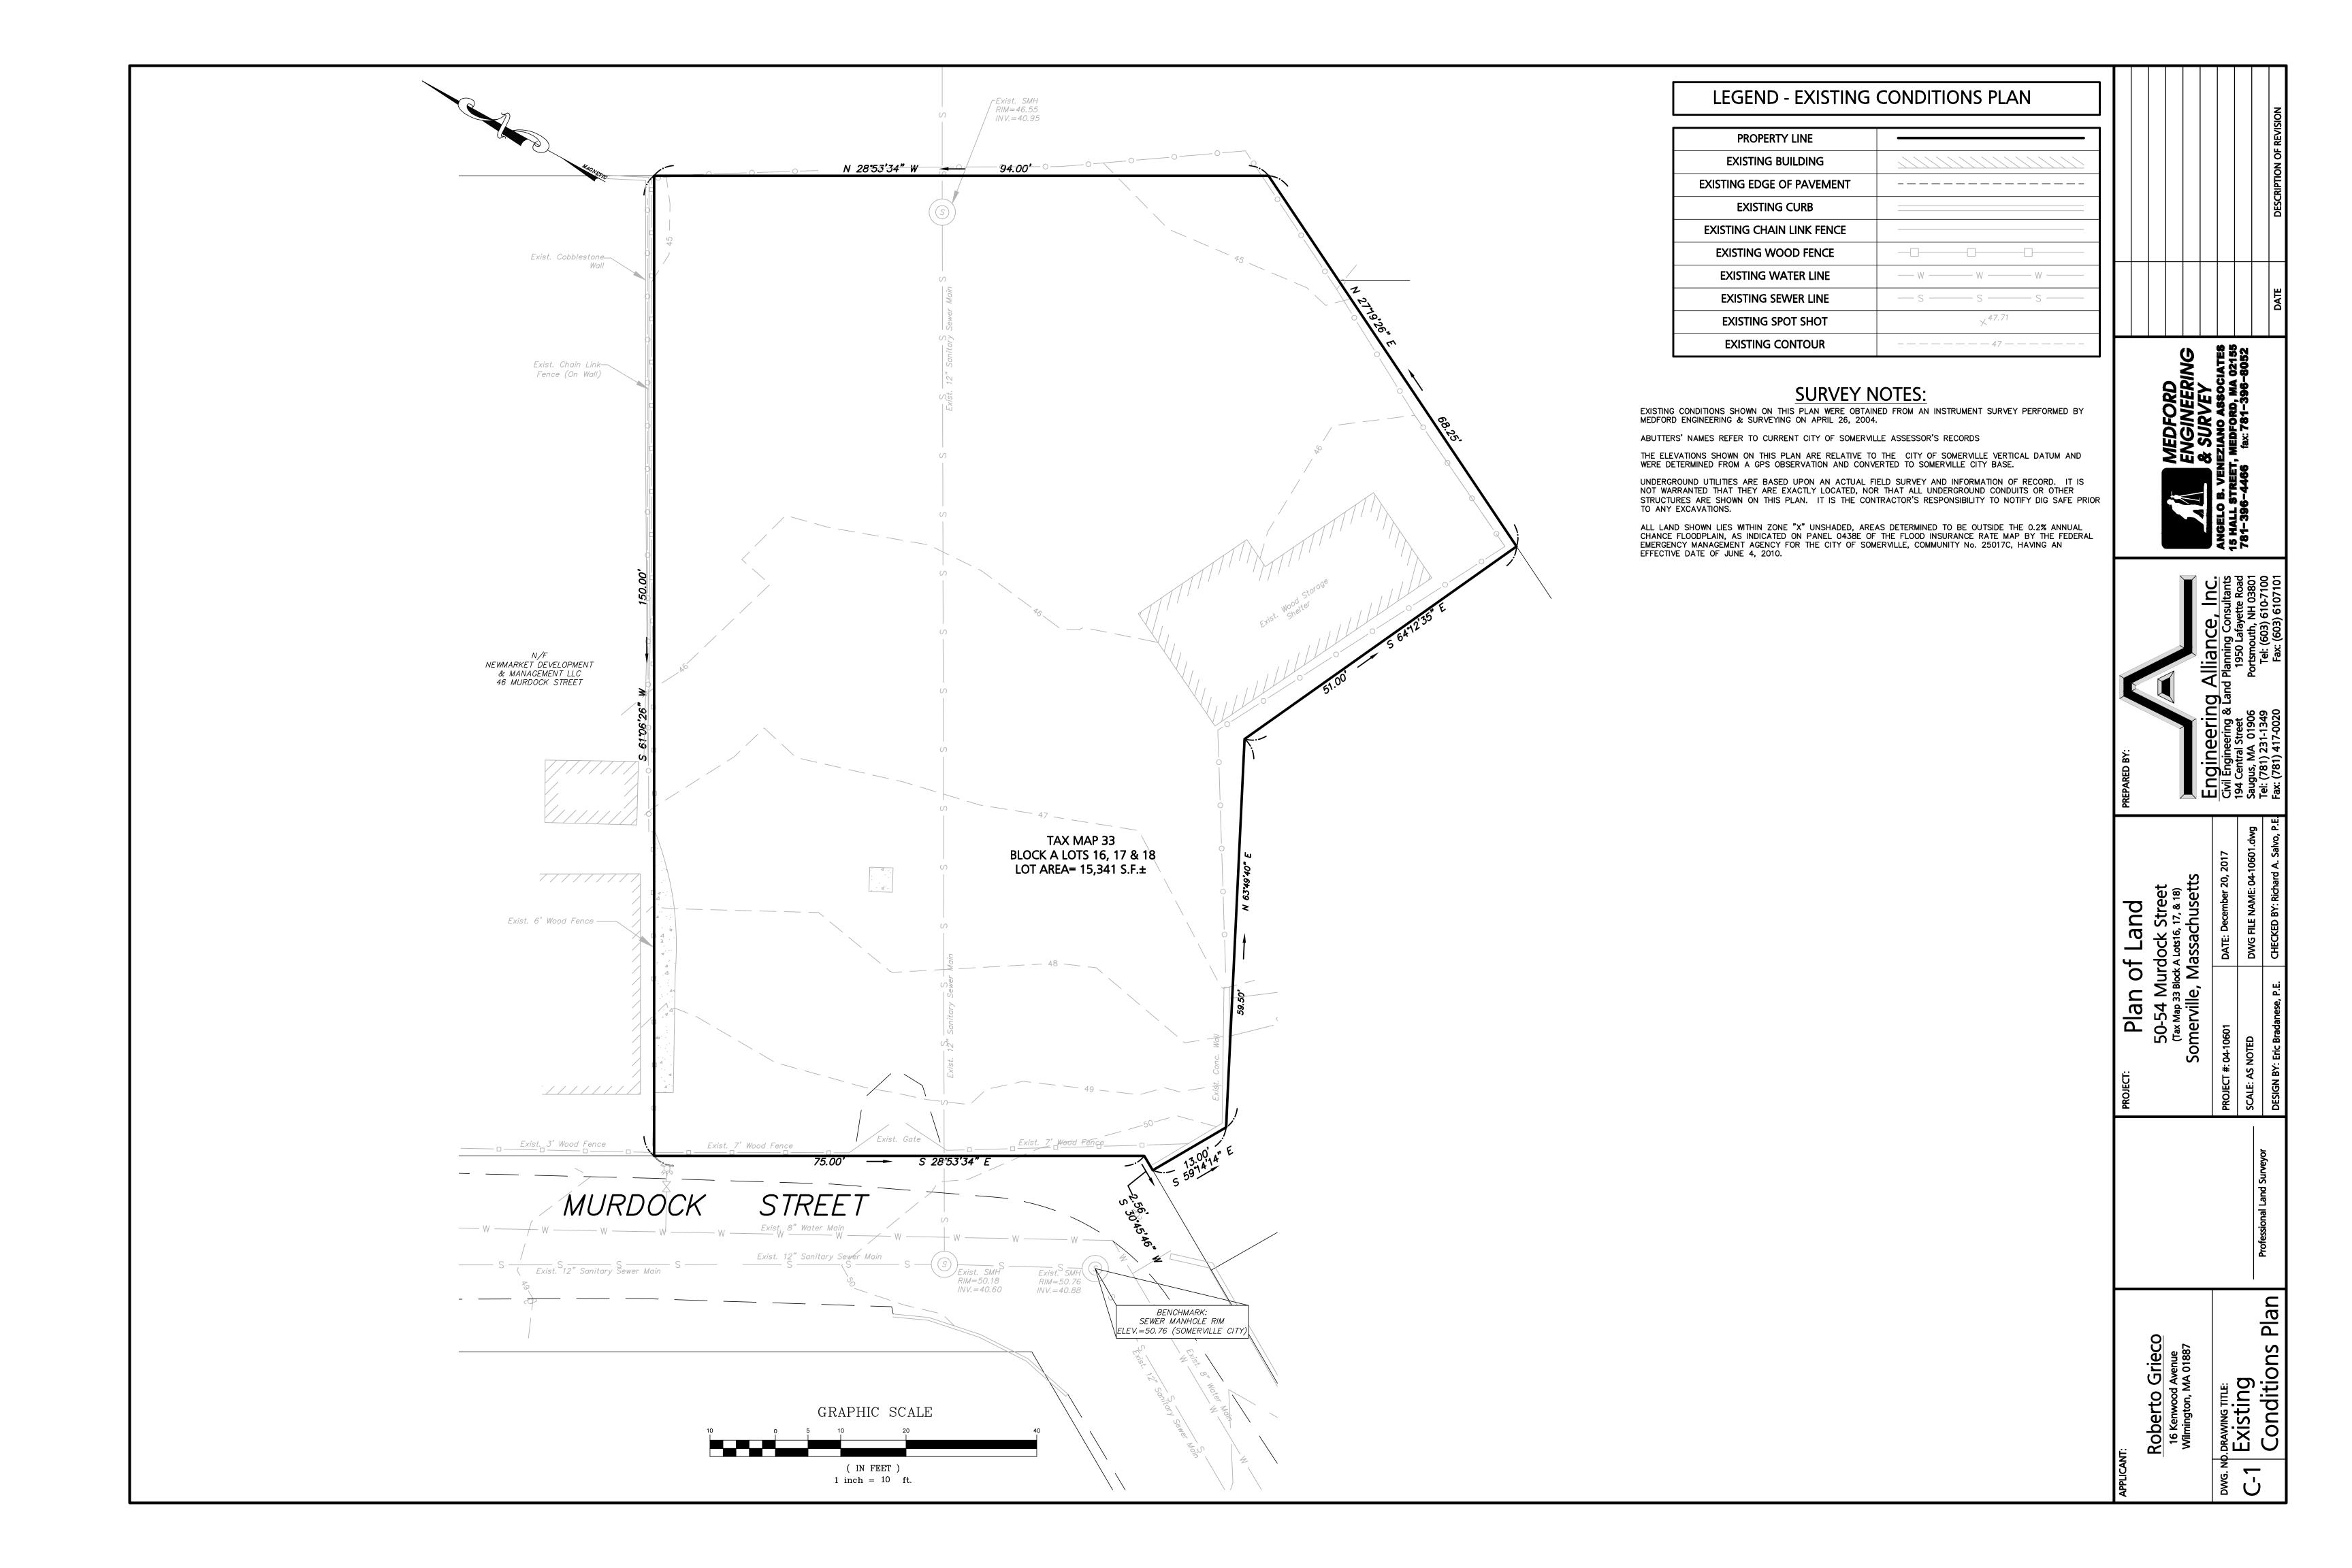

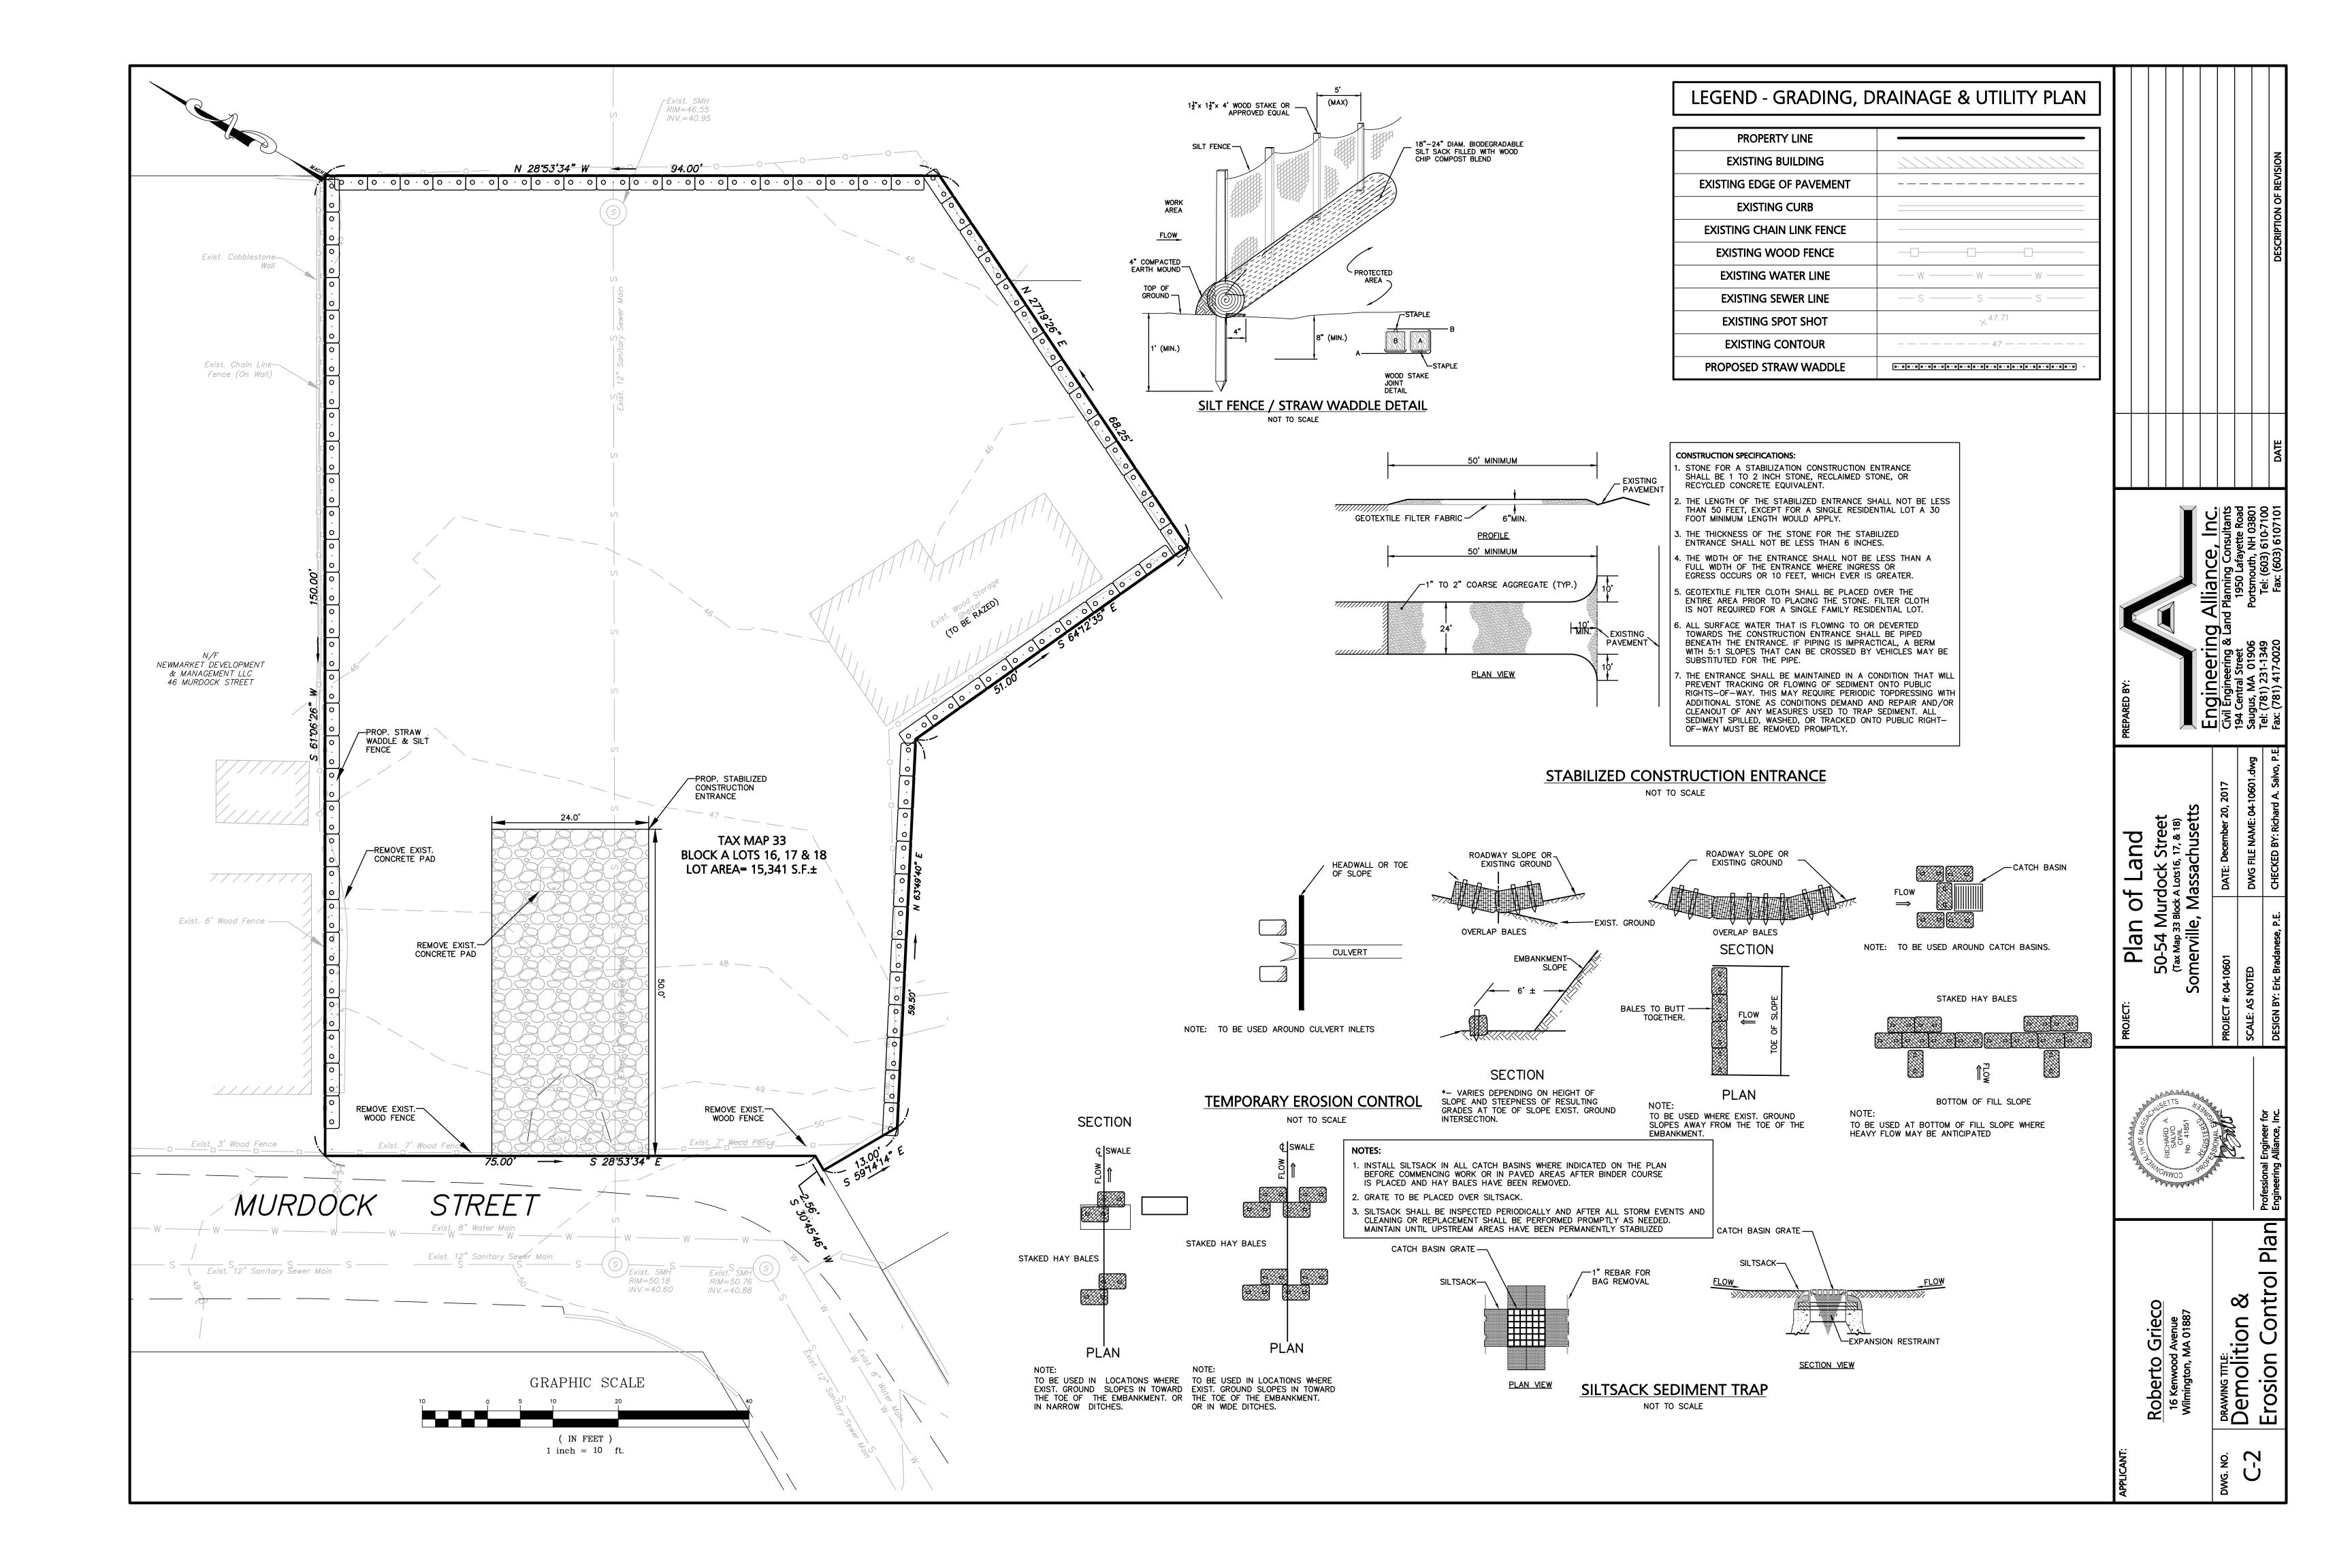

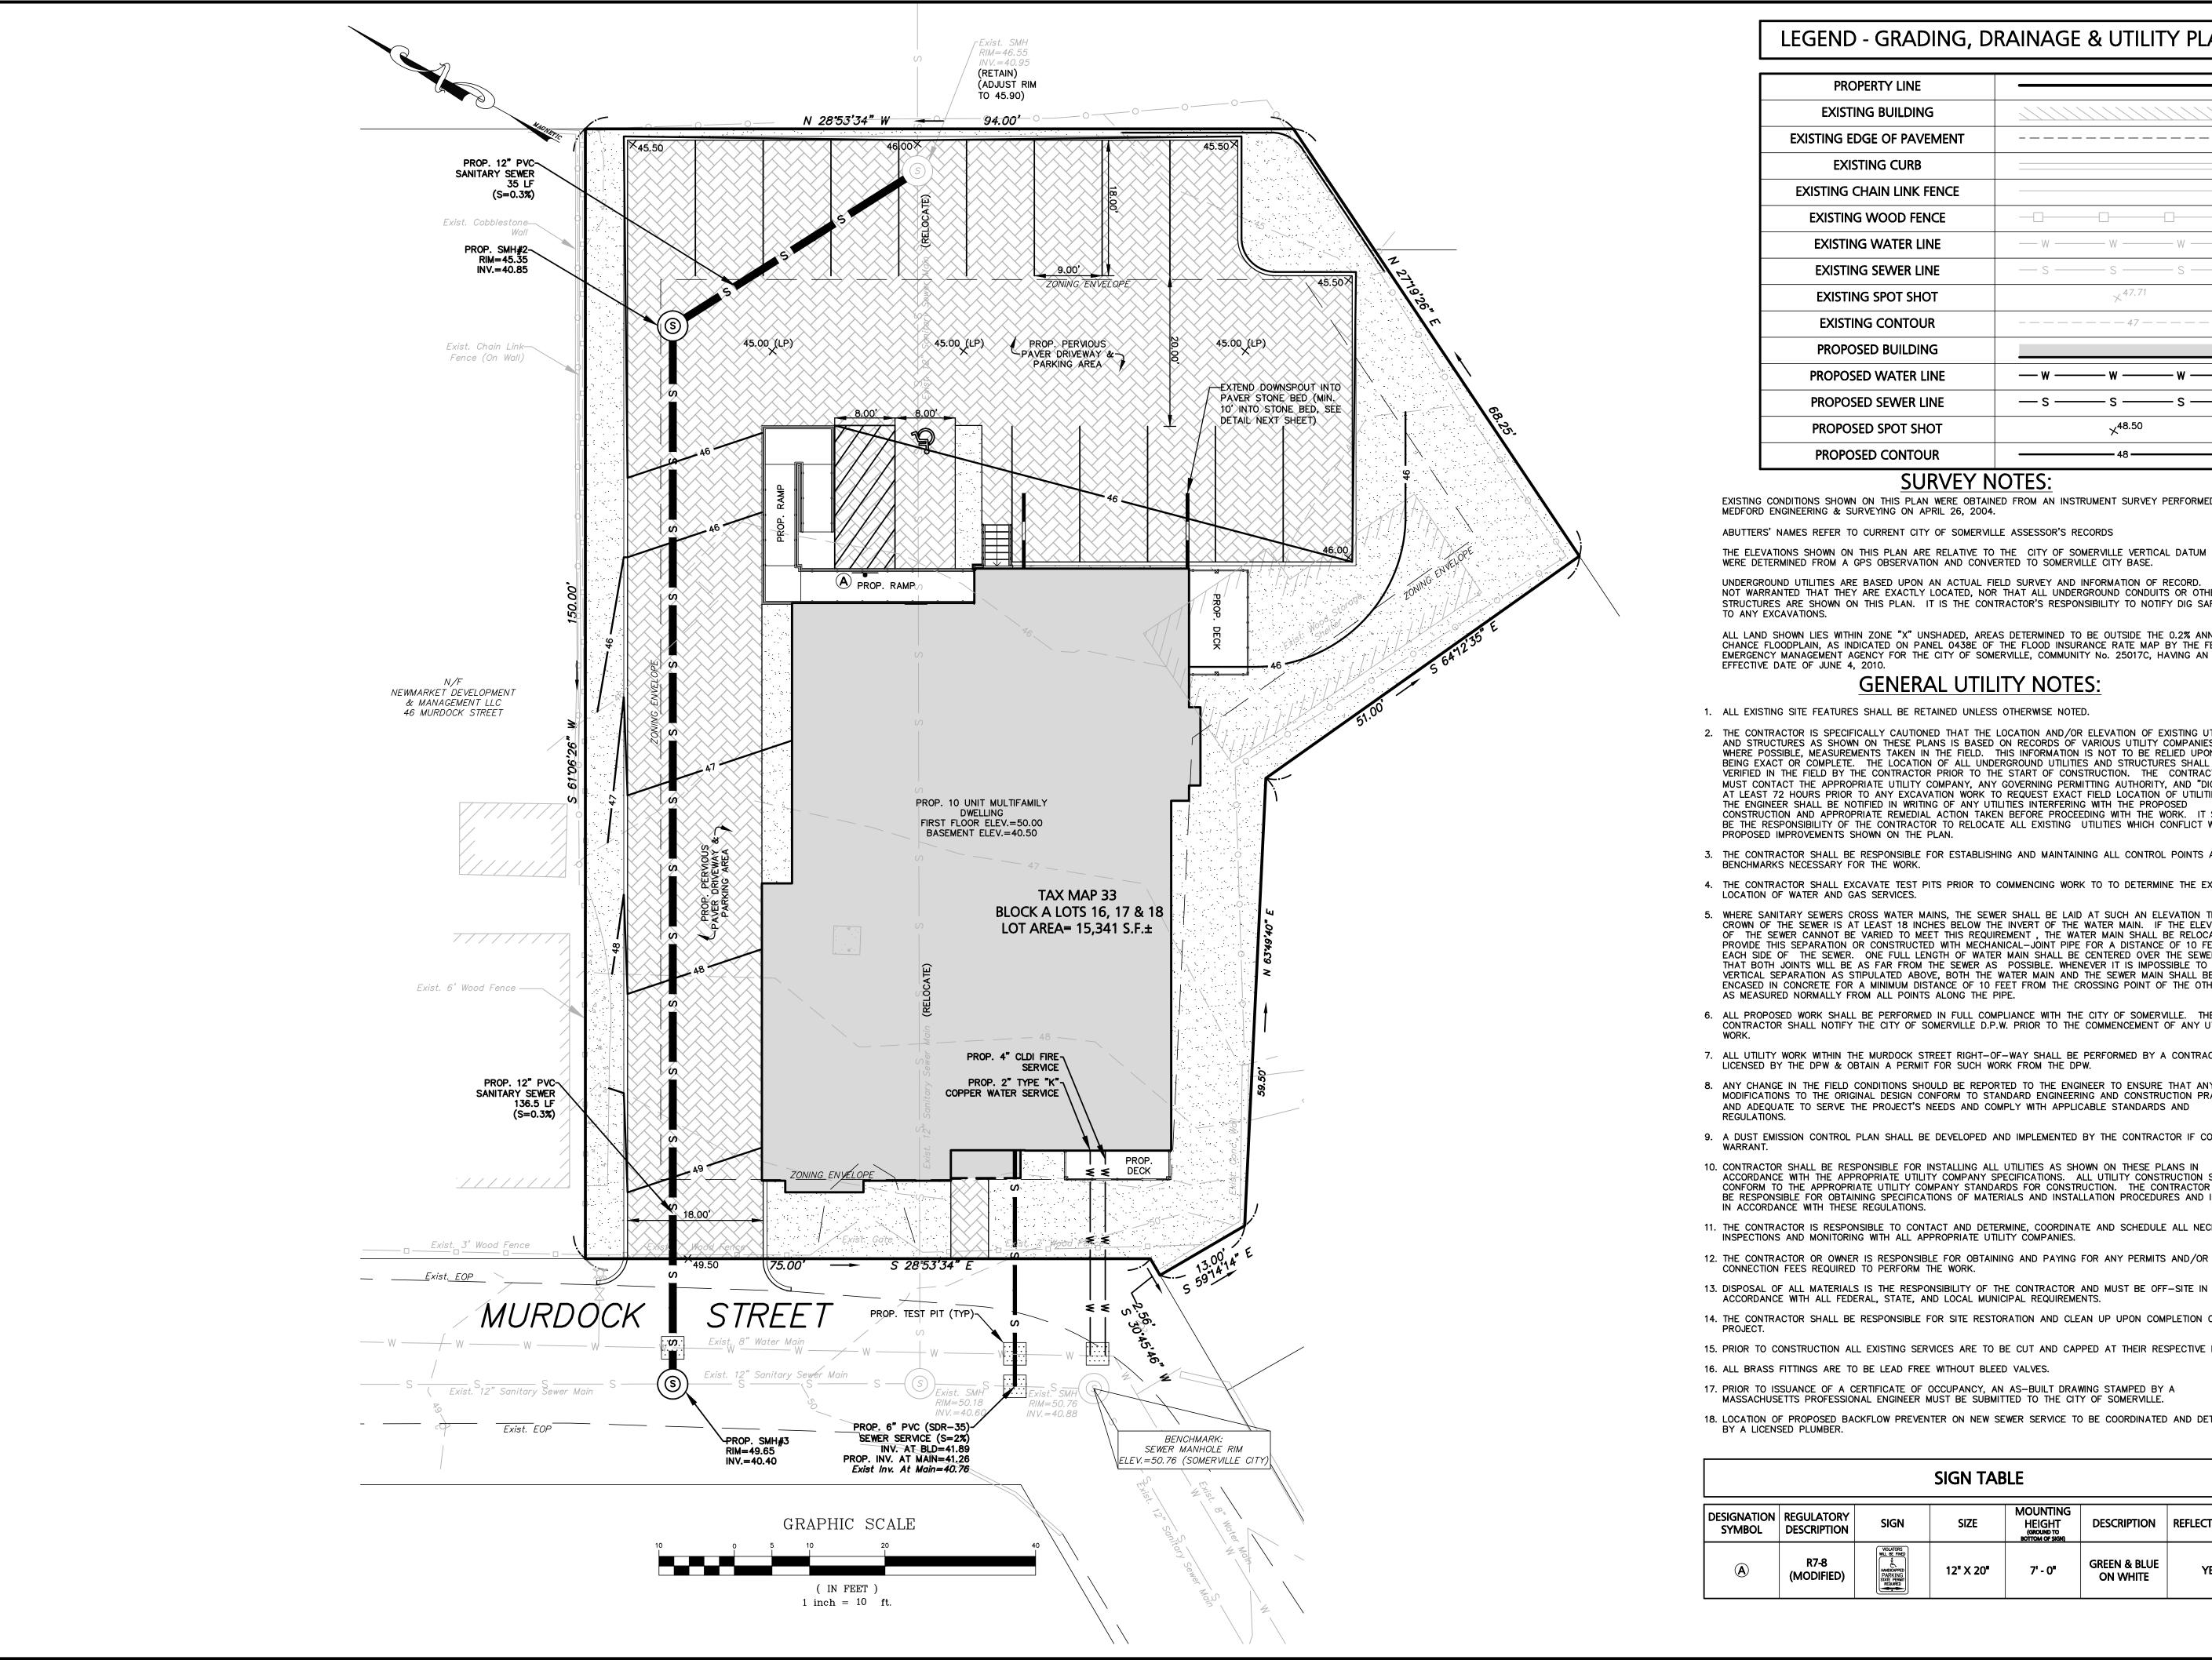

## LEGEND - GRADING, DRAINAGE & UTILITY PLAN

PROPERTY LINE	
EXISTING BUILDING	
EXISTING EDGE OF PAVEMENT	
EXISTING CURB	
EXISTING CHAIN LINK FENCE	
EXISTING WOOD FENCE	-00
EXISTING WATER LINE	— w — w — w —
EXISTING SEWER LINE	— s —— s —— s —
EXISTING SPOT SHOT	× <sup>47.71</sup>
EXISTING CONTOUR	
PROPOSED BUILDING	
PROPOSED WATER LINE	www
PROPOSED SEWER LINE	sss
PROPOSED SPOT SHOT	× <sup>48.50</sup>
PROPOSED CONTOUR	48

### **SURVEY NOTES:**

EXISTING CONDITIONS SHOWN ON THIS PLAN WERE OBTAINED FROM AN INSTRUMENT SURVEY PERFORMED BY MEDFORD ENGINEERING & SURVEYING ON APRIL 26, 2004.

ABUTTERS' NAMES REFER TO CURRENT CITY OF SOMERVILLE ASSESSOR'S RECORDS

THE ELEVATIONS SHOWN ON THIS PLAN ARE RELATIVE TO THE CITY OF SOMERVILLE VERTICAL DATUM AND WERE DETERMINED FROM A GPS OBSERVATION AND CONVERTED TO SOMERVILLE CITY BASE.

UNDERGROUND UTILITIES ARE BASED UPON AN ACTUAL FIELD SURVEY AND INFORMATION OF RECORD. IT IS NOT WARRANTED THAT THEY ARE EXACTLY LOCATED, NOR THAT ALL UNDERGROUND CONDUITS OR OTHER STRUCTURES ARE SHOWN ON THIS PLAN. IT IS THE CONTRACTOR'S RESPONSIBILITY TO NOTIFY DIG SAFE PRIOR

ALL LAND SHOWN LIES WITHIN ZONE "X" UNSHADED, AREAS DETERMINED TO BE OUTSIDE THE 0.2% ANNUAL CHANCE FLOODPLAIN, AS INDICATED ON PANEL 0438E OF THE FLOOD INSURANCE RATE MAP BY THE FEDERAL EMERGENCY MANAGEMENT AGENCY FOR THE CITY OF SOMERVILLE, COMMUNITY No. 25017C, HAVING AN EFFECTIVE DATE OF JUNE 4, 2010.

### **GENERAL UTILITY NOTES:**


- 1. ALL EXISTING SITE FEATURES SHALL BE RETAINED UNLESS OTHERWISE NOTED.
- 2. THE CONTRACTOR IS SPECIFICALLY CAUTIONED THAT THE LOCATION AND/OR ELEVATION OF EXISTING UTILITIES AND STRUCTURES AS SHOWN ON THESE PLANS IS BASED ON RECORDS OF VARIOUS UTILITY COMPANIES AND WHERE POSSIBLE, MEASUREMENTS TAKEN IN THE FIELD. THIS INFORMATION IS NOT TO BE RELIED UPON AS BEING EXACT OR COMPLETE. THE LOCATION OF ALL UNDERGROUND UTILITIES AND STRUCTURES SHALL BE VERIFIED IN THE FIELD BY THE CONTRACTOR PRIOR TO THE START OF CONSTRUCTION. THE CONTRACTOR MUST CONTACT THE APPROPRIATE UTILITY COMPANY, ANY GOVERNING PERMITTING AUTHORITY, AND "DIGSAFE" AT LEAST 72 HOURS PRIOR TO ANY EXCAVATION WORK TO REQUEST EXACT FIELD LOCATION OF UTILITIES AND THE ENGINEER SHALL BE NOTIFIED IN WRITING OF ANY UTILITIES INTERFERING WITH THE PROPOSED CONSTRUCTION AND APPROPRIATE REMEDIAL ACTION TAKEN BEFORE PROCEEDING WITH THE WORK. IT SHALL BE THE RESPONSIBILITY OF THE CONTRACTOR TO RELOCATE ALL EXISTING UTILITIES WHICH CONFLICT WITH THE PROPOSED IMPROVEMENTS SHOWN ON THE PLAN.
- 3. THE CONTRACTOR SHALL BE RESPONSIBLE FOR ESTABLISHING AND MAINTAINING ALL CONTROL POINTS AND
- 4. THE CONTRACTOR SHALL EXCAVATE TEST PITS PRIOR TO COMMENCING WORK TO TO DETERMINE THE EXACT LOCATION OF WATER AND GAS SERVICES.
- 5. WHERE SANITARY SEWERS CROSS WATER MAINS, THE SEWER SHALL BE LAID AT SUCH AN ELEVATION THAT THE CROWN OF THE SEWER IS AT LEAST 18 INCHES BELOW THE INVERT OF THE WATER MAIN. IF THE ELEVATION OF THE SEWER CANNOT BE VARIED TO MEET THIS REQUIREMENT, THE WATER MAIN SHALL BE RELOCATED TO PROVIDE THIS SEPARATION OR CONSTRUCTED WITH MECHANICAL-JOINT PIPE FOR A DISTANCE OF 10 FEET ON EACH SIDE OF THE SEWER. ONE FULL LENGTH OF WATER MAIN SHALL BE CENTERED OVER THE SEWER SO THAT BOTH JOINTS WILL BE AS FAR FROM THE SEWER AS POSSIBLE. WHENEVER IT IS IMPOSSIBLE TO OBTAIN VERTICAL SEPARATION AS STIPULATED ABOVE, BOTH THE WATER MAIN AND THE SEWER MAIN SHALL BE ENCASED IN CONCRETE FOR A MINIMUM DISTANCE OF 10 FEET FROM THE CROSSING POINT OF THE OTHER PIPE AS MEASURED NORMALLY FROM ALL POINTS ALONG THE PIPE.
- 6. ALL PROPOSED WORK SHALL BE PERFORMED IN FULL COMPLIANCE WITH THE CITY OF SOMERVILLE. THE CONTRACTOR SHALL NOTIFY THE CITY OF SOMERVILLE D.P.W. PRIOR TO THE COMMENCEMENT OF ANY UTILITY
- 7. ALL UTILITY WORK WITHIN THE MURDOCK STREET RIGHT-OF-WAY SHALL BE PERFORMED BY A CONTRACTOR LICENSED BY THE DPW & OBTAIN A PERMIT FOR SUCH WORK FROM THE DPW.
- 8. ANY CHANGE IN THE FIELD CONDITIONS SHOULD BE REPORTED TO THE ENGINEER TO ENSURE THAT ANY MODIFICATIONS TO THE ORIGINAL DESIGN CONFORM TO STANDARD ENGINEERING AND CONSTRUCTION PRACTICES AND ADEQUATE TO SERVE THE PROJECT'S NEEDS AND COMPLY WITH APPLICABLE STANDARDS AND
- 9. A DUST EMISSION CONTROL PLAN SHALL BE DEVELOPED AND IMPLEMENTED BY THE CONTRACTOR IF CONDITIONS
- 10. CONTRACTOR SHALL BE RESPONSIBLE FOR INSTALLING ALL UTILITIES AS SHOWN ON THESE PLANS IN ACCORDANCE WITH THE APPROPRIATE UTILITY COMPANY SPECIFICATIONS. ALL UTILITY CONSTRUCTION SHALL CONFORM TO THE APPROPRIATE UTILITY COMPANY STANDARDS FOR CONSTRUCTION. THE CONTRACTOR SHALL BE RESPONSIBLE FOR OBTAINING SPECIFICATIONS OF MATERIALS AND INSTALLATION PROCEDURES AND INSTALL IN ACCORDANCE WITH THESE REGULATIONS.
- 11. THE CONTRACTOR IS RESPONSIBLE TO CONTACT AND DETERMINE, COORDINATE AND SCHEDULE ALL NECESSARY INSPECTIONS AND MONITORING WITH ALL APPROPRIATE UTILITY COMPANIES.
- CONNECTION FEES REQUIRED TO PERFORM THE WORK.
- 13. DISPOSAL OF ALL MATERIALS IS THE RESPONSIBILITY OF THE CONTRACTOR AND MUST BE OFF-SITE IN ACCORDANCE WITH ALL FEDERAL, STATE, AND LOCAL MUNICIPAL REQUIREMENTS.
- 14. THE CONTRACTOR SHALL BE RESPONSIBLE FOR SITE RESTORATION AND CLEAN UP UPON COMPLETION OF THE
- 15. PRIOR TO CONSTRUCTION ALL EXISTING SERVICES ARE TO BE CUT AND CAPPED AT THEIR RESPECTIVE MAINS. 16. ALL BRASS FITTINGS ARE TO BE LEAD FREE WITHOUT BLEED VALVES.
- 17. PRIOR TO ISSUANCE OF A CERTIFICATE OF OCCUPANCY, AN AS-BUILT DRAWING STAMPED BY A MASSACHUSETTS PROFESSIONAL ENGINEER MUST BE SUBMITTED TO THE CITY OF SOMERVILLE.
- 18. LOCATION OF PROPOSED BACKFLOW PREVENTER ON NEW SEWER SERVICE TO BE COORDINATED AND DETERMINED BY A LICENSED PLUMBER.

SIGN TABLE						
DESIGNATION SYMBOL	REGULATORY DESCRIPTION	SIGN	SIZE	MOUNTING HEIGHT (GROUND TO BOTTOM OF SIGN)	DESCRIPTION	REFLECTORIZED
A	R7-8 (MODIFIED)	VIOLATORS WILL BE FINED  L HANDICAPPED PARKING STATE PERMIT REQUIRED	12" X 20"	7' - 0"	GREEN & BLUE ON WHITE	YES

							į
			Inc.	ultants	te Road	10-2401	101101

Roberto 16 Kenwood <u>\_</u>

Site

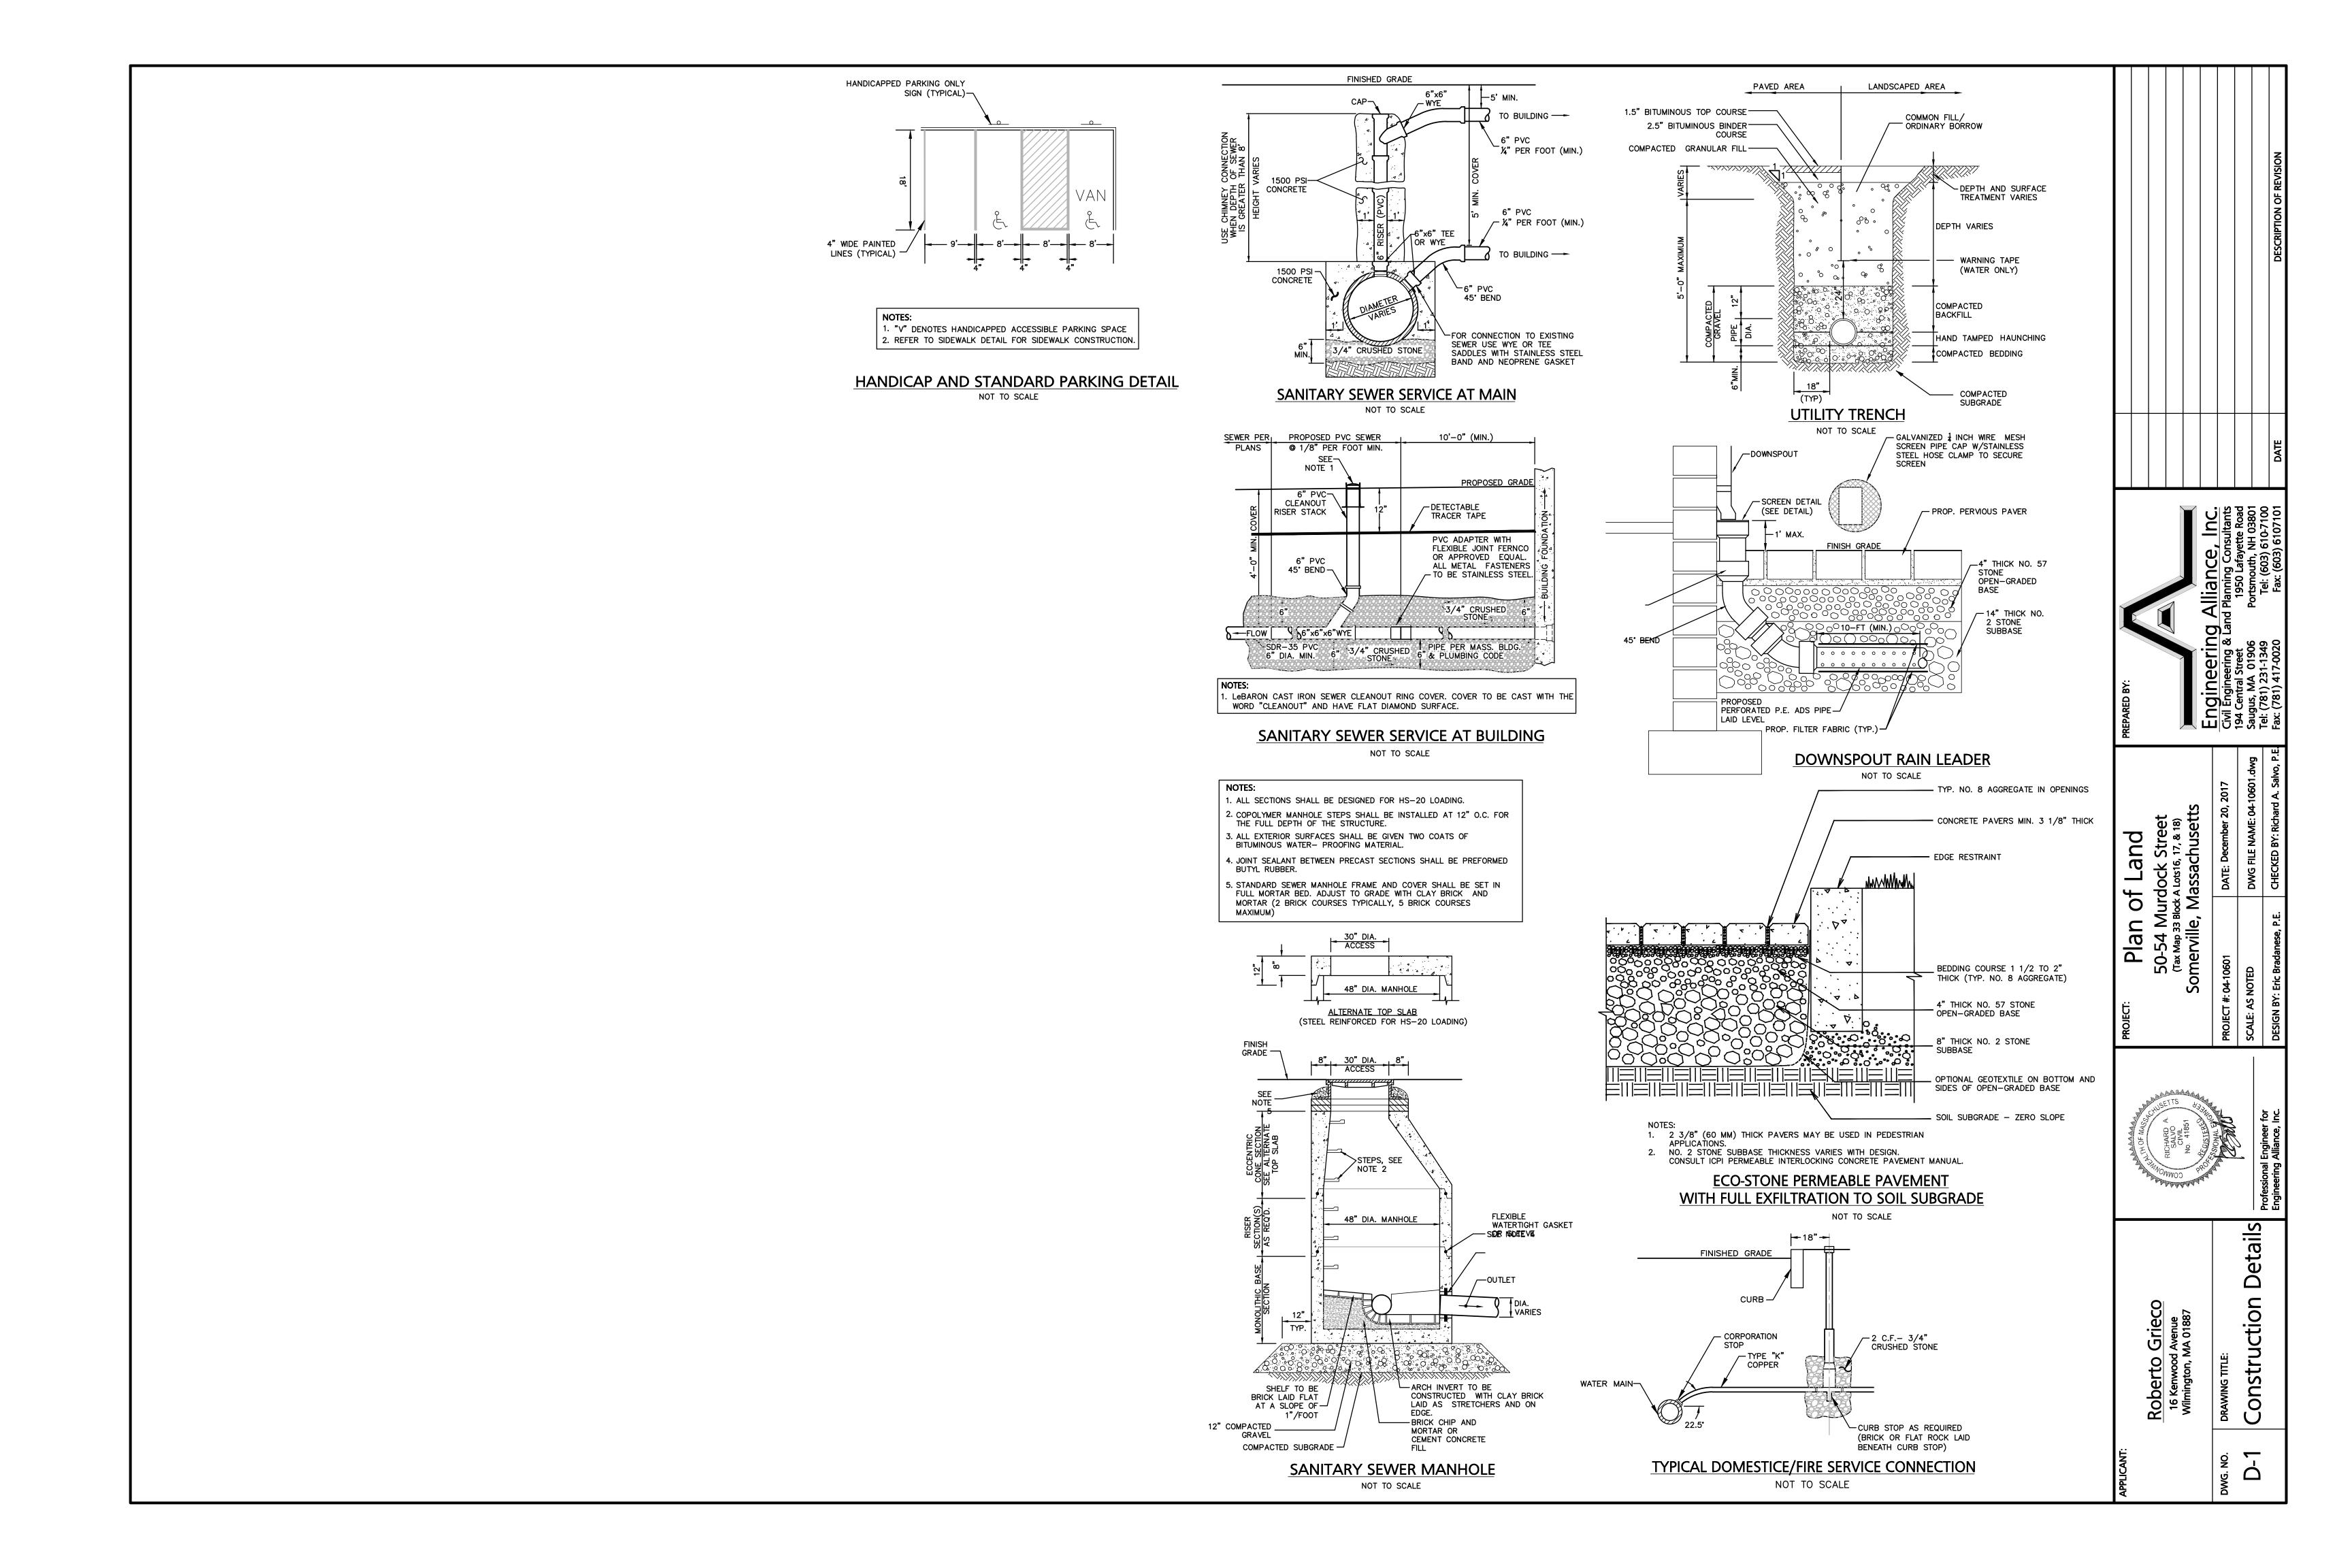



#### PROPOSED PLANT LIST

1	AR	Acer rubrum 'Armstrong'	Fastigiate Red Maple	2.5" cal. B&B
4	LT	Liriodendron tluipifera	Tuliptree	3" cal. B&B
7	QP	Quercus palustris 'Pringreen'	Green Pillar Pin Oak	
Shrub	os:			
12	DB	Daphne x burkwoodii 'Carol Mackie'	Carol Mackie Daphne	5 gal. pots
2	HA	Hydrangea annabelle	Annabelle Hydrangea	36" ht.
37	IG	llex glabra 'Shamrock'	Shamrock Inberry	24" ht.
13	IV	Itea virginica 'Henry's Garnet'	Henry's Garnet Sweetspire	5 gal. pots
4	PJ	Pieris japonica 'Mountain Fire'	Mountain Fire Pieris	24" ht.
6	RC	Rhododendron catawbiense 'Grandiflorum'	Grandiflorum Rhododendron	36-48" ht. B&B
3	SJ	Spiraea japonica 'Anthony Waterer'	Anthony Waterer Spiraea	24-36" ht. B&B
16	SP	Spiraea japonica 'Little Princess'	Little Princess Spiraea	24" ht. B&B
16	TM	Taxus x media 'Nigra'	Dwarf Spreading Yew	24-36" ht. B&B
3	VC	Viburnum carlesii	Korean Spice Viburnum	36" ht. B&B
Vines	+ Gro	oundcover:		
21	CC	Clematis candida	Clematis	I gal. pots
18	PQ	Parthenosisus quincefolia	Woodbine	I gal pots
420	vm	Vinca minor 'Ralph Shugert'	Periwinkle	I qt. pots


### **PLANTING NOTES**

- I. All plant material shall be approved by the Landscape Architect prior to arrival on the site.
- 2. All plant material shall conform to the guidelines established by "The American Standard for Nursery Stock", published by the American Hort.
- 3. No substitution of plant species will be allowed without the written approval of the Landscape Architect. Any proposed substitutions of plant species shall be a plant of equivalent overall form, height and branching habit, flower, leaf and fruit, color the first 24 hours. and time of bloom.
- 4. The Contractor shall locate and verify all utility line locations prior to excavation for tree pits and report any conflicts to the Landscape Architect.
- 5. All plants shall be placed in their approximate location by the Contractor. The Contractor shall adjust the locations as required by the Landscape Architect. Trees shall be placed first, then shrubs, then perennials and last, groundcovers. Final locations must be approved by the Landscape Architect prior to planting.

- 6. The rootballs of trees shall be planted 3" above adjacent finished grade. The rootballs of shrubs shall be planted 2" above adjacent finished grade. The rootflare of perennials shall be set at the level at which the plant was growing.
- 7. All planting to be done under the full time supervision of a certified arborist, nurseryman or licensed Landscape Architect.
- 8. All plants are to be thoroughly watered after installation, at least twice within the first 24 hours.
- 9. The Landscape Subcontractor shall coordinate with the General Contractor and Site Subcontractor all the requirements for subsoil testing and preparation and testing and placing of approved topsoil and planting soil mixes as described in the specifications. Failure of the site or General Contractor to perform required testing, subsoil and topsoil preparation does not relieve the Landscape Contractor from the requirements of the work as set forth in the specifications.



Wood Trellis with Vines

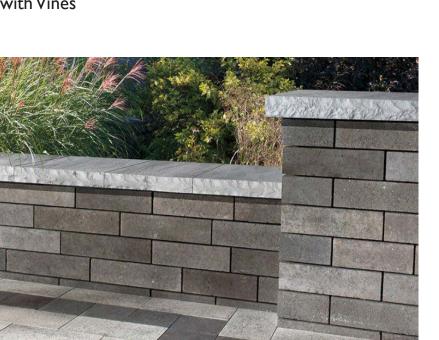


Garden Wall, 2' ht. | 'Lineo' by Unilock




Solid Wood Board Fence, 6' ht.




Permeable Pavers | 'EcoPriora' by Unilock

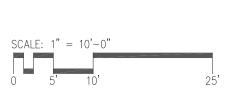


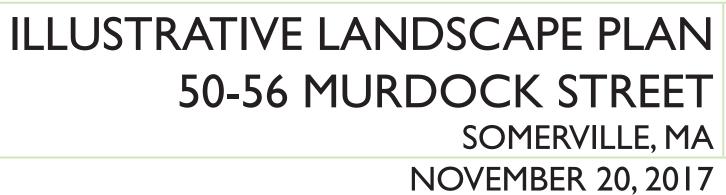





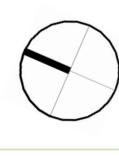

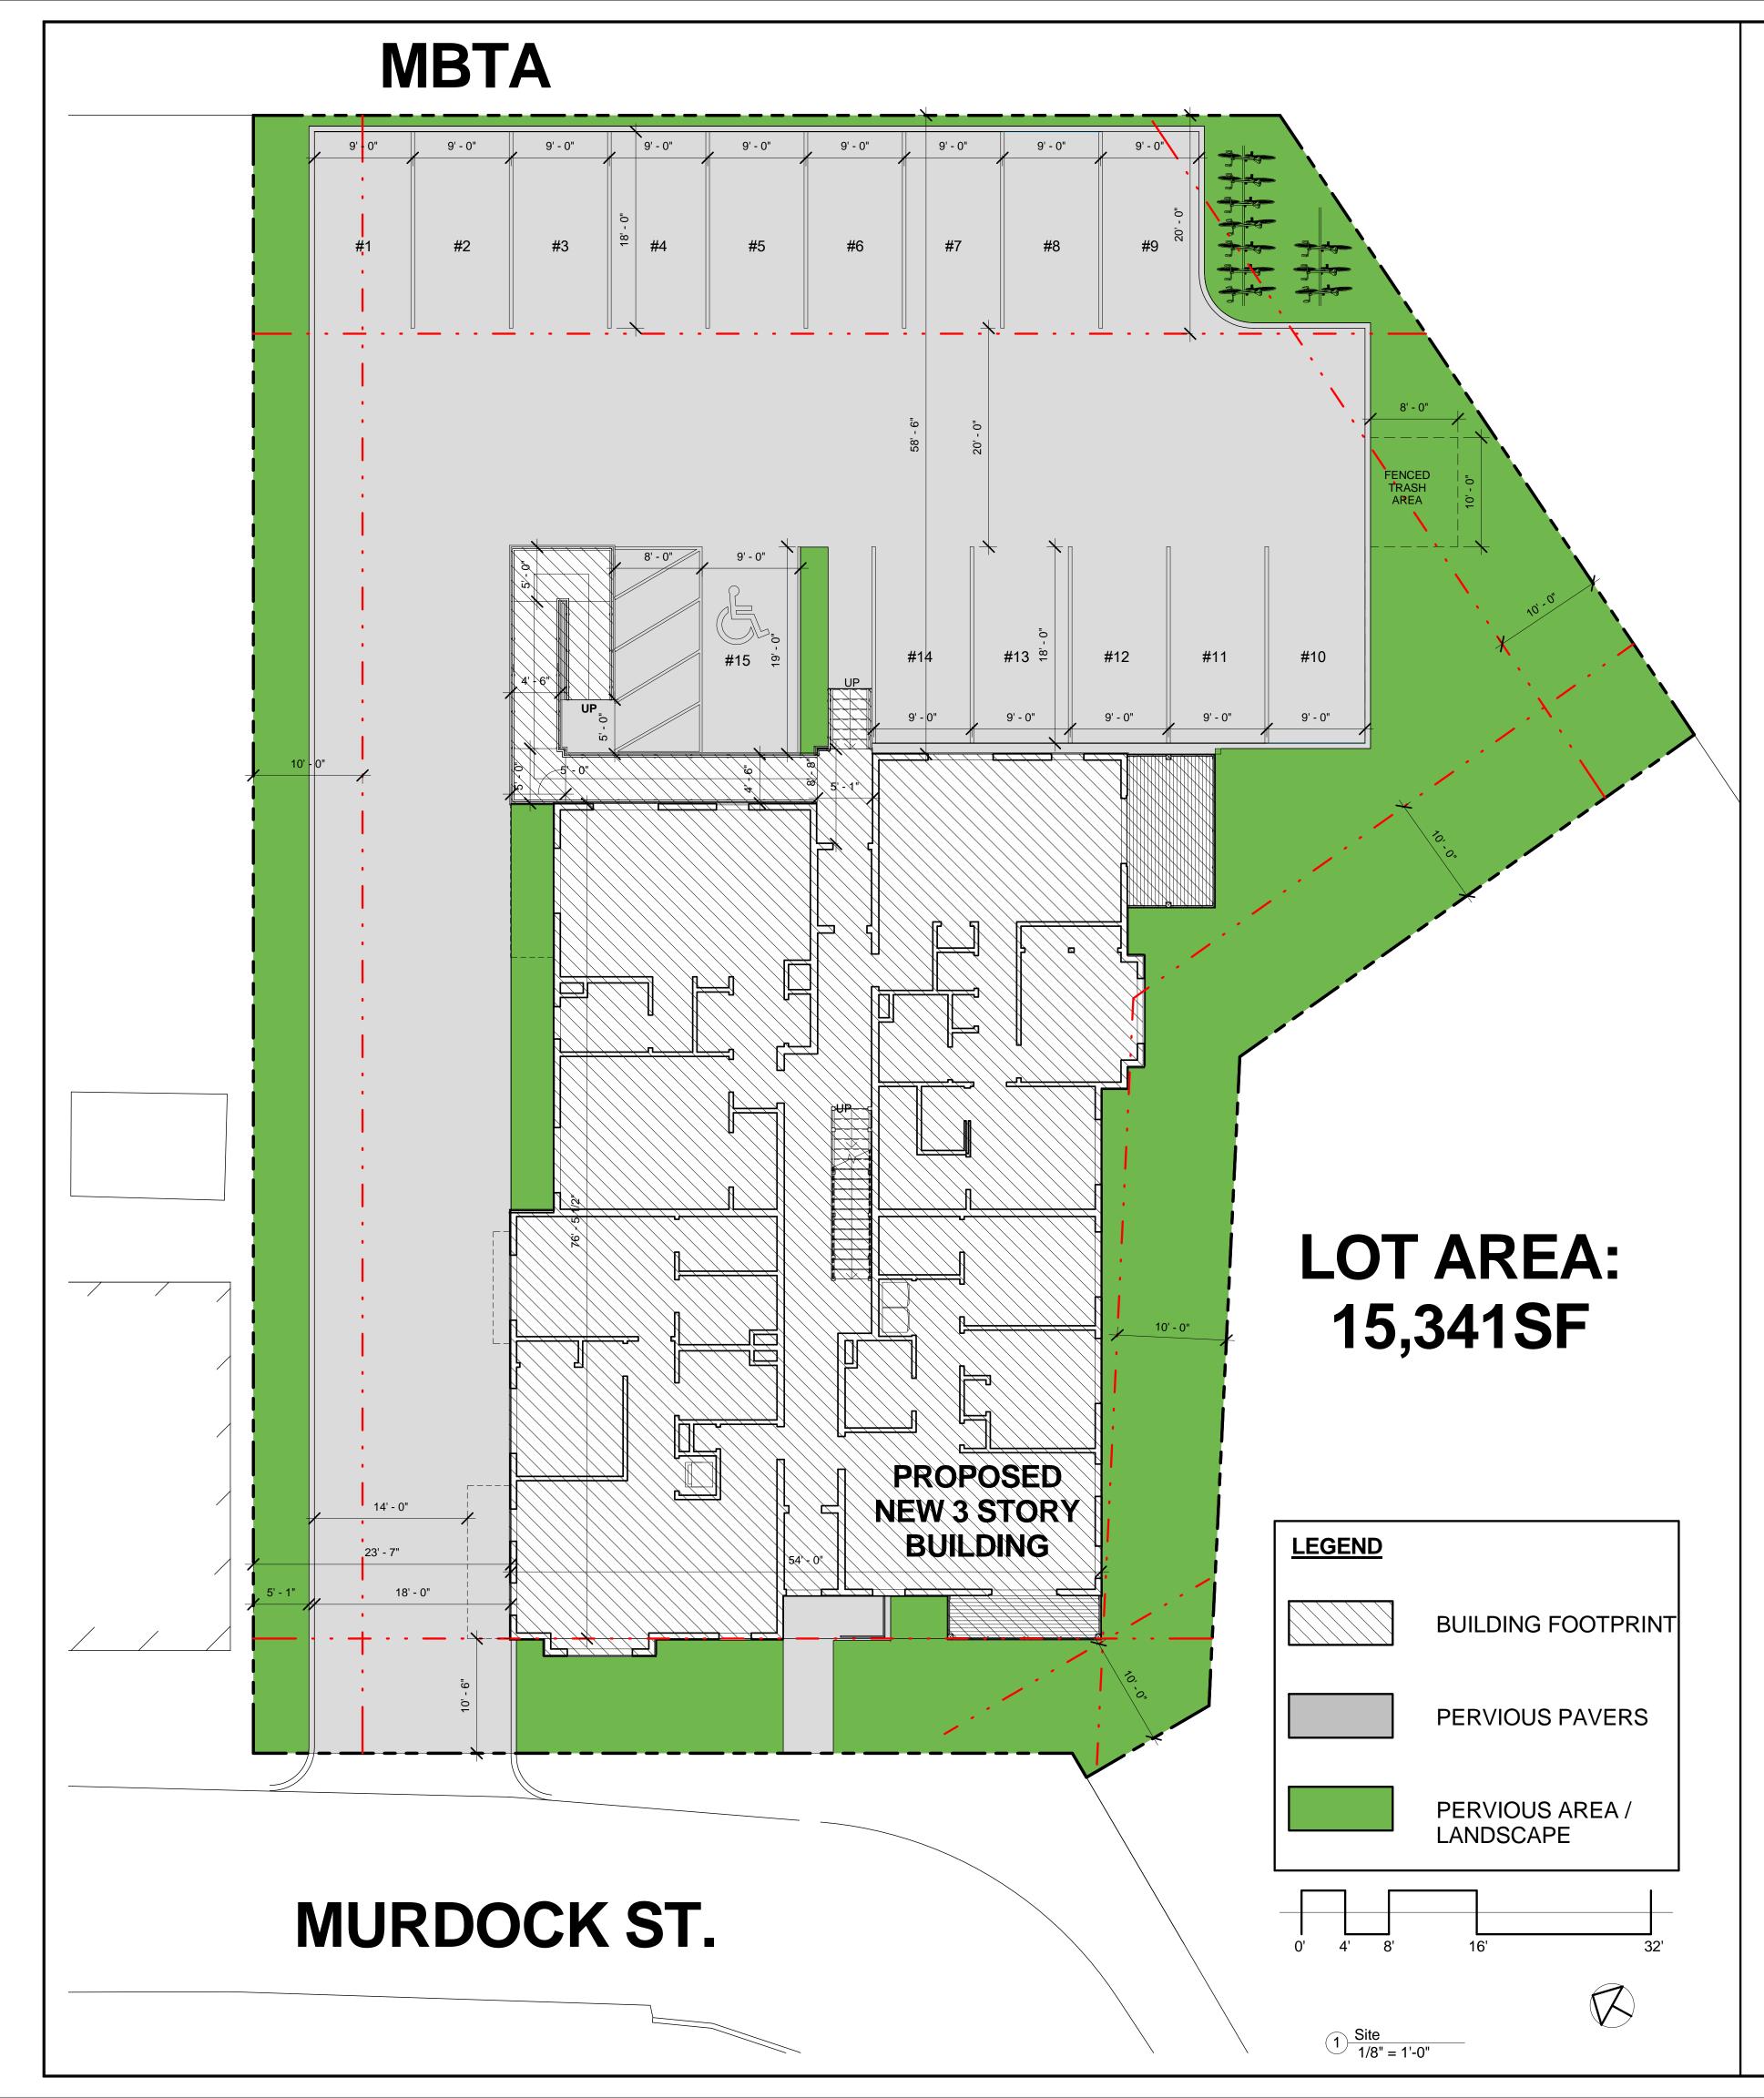

ZONING DIMENSIONAL TABLE						
	REQUIRED	PROPOSED	COMPLIANCE			
ZONE	RB ZONE					
USE	MULTI-FAMILY	MULTI-FAMILY	COMPLIES			
MIN. LOT SIZE	7,500 SF	15,341 SF	COMPLIES			
MIN LOT PER DWELLING	1-9 UNITS/ 1500 SF/DU	2,007 SF/DU	COMPLIES			
MAX GROUND COVERAGE	50%	4,676 SF (30%)	COMPLIES			
LANDSCAPE AREA	25% (3,835 SF)	3,886 SF (25.33%)	COMPLIES			
FLOOR AREA RATIO	1.0	0.79 (12,105 SF)	COMPLIES			
MAX BUILDING HEIGHT	40'-0" / 3ST	40'-0" / 3ST	COMPLIES			
MIN YARD FRONT SIDE REAR	15'-0" 10'-0" 20'-0"	10'-6" (SEE NOTE) 23'-7" (L) 10'-0" (R) 58'-6"	COMPLIES			
MIN FRONTAGE	50'-0"	90'-5"	COMPLIES			
PERVIOUS AREA	35%	5,369 SF (35%)	COMPLIES			
PARKING REQUIREMENTS	14 STANDARD & 1 HC	14 STANDARD & 1 HC	COMPLIES			
BICYCLE PARKING	1 PER / DU	10	COMPLIES			

1. THE FRONT SETBACK IS REDUCED DUE TO THE EXISTING FRONT SETBACK OF NEIGHBORING LOTS

SECTION 9.9. - DRIVEWAYS, ACCESS, AND LIGHTING REQUIREMENTS
Required parking and loading facilities shall comply with the following:

 Access Via Driveway and Maneuvering Aisle. Each parking space and loading bay shall be connected by a maneuvering aisle and driveway to a street. Parts of a driveway may be partly on another lot or may straddle a lot line where there is a recorded easement or lease allowing such right of use and provided the SPGA grants a special permit under Section 9.13. This requirement shall not be applicable in the University District.
 Driveway Dimensions. The width of a driveway for a one-way use shall be a minimum of eight (8) feet and for two-way use shall be a minimum of eighteen (18) feet and a maximum of thirty (30) feet. Driveways serving parking for up to three (3) dwelling units shall be a minimum of eight (8) feet and a maximum of twelve (12) feet in width, provided the driveway has direct access to a public way. See the provisions of Section 9.11, particularly Sec. 9.11(e), for parking bay, circulation and maneuverability considerations influencing the need for one-way or two-way directional driveways.

	FAR Area	
Level	Area	Comments
1st Floor	3999 SF	
2nd Floor	4051 SF	
3rd Floor	4055 SF	
Grand total: 3	12105 SF	

Gross Building Area					
Level	Area	Comments			
Basement Floor	4027 SF				
1st Floor	4056 SF				
2nd Floor	4112 SF				
3rd Floor	4112 SF				
Total:	16,307 SF				

PROJECT NAME

# **Murdock Street** Residences

PROJECT ADDRESS

50-54 Murdock Street, Somerville, MA

CLIENT

**Rob Grieco** 

ARCHITECT




17 IVALOO STREET SUITE 400 SOMERVILLE, MA 02143 TELEPHONE: 617-591-8682 FAX: 617-591-2086

CONSULTANTS:

COPYRIGHT KDI © 2017 THESE DRAWINGS ARE NOW AND DO REMAIN THE SOLE PROPERTY OF KHALSA WRITTEN CONSENT IS PROHIBITED AND SHALL RESULT IN THE FULLEST EXTENT OF

REGISTRATION

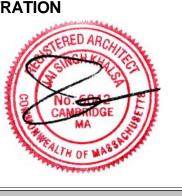

Date		17 10 12/29/201
Drawn by		N
Checked b	DV	JS
		s indicate
REVISIO	DNS	
No.	Description	Date
		1

Architectural Site Plan & Zoning Analysis

Murdock Street Residences

PROJECT NAME

**Murdock Street** Residences

50-54 Murdock Street,

**Rob Grieco** 



17 IVALOO STREET SUITE 400 SOMERVILLE, MA 02143 TELEPHONE: 617-591-8682 FAX: 617-591-2086

COPYRIGHT KDI © 2017 THESE DRAWINGS ARE NOW AND DO REMAIN THE SOLE PROPERTY OF KHALSA DESIGN INC. USE OF THESE PLANS OR ANY FORM OF REPRODUCTION OF THIS DESIGN
IN WHOLE OR IN PART WITHOUT EXPRESS
WRITTEN CONSENT IS PROHIBITED AND
SHALL RESULT IN THE FULLEST EXTENT OF
PROSECUTION UNDER LAW



17107

Date		12/29/2017
Drawn by		NB
Checked	by	JSK
Scale	;	3/16" = 1'-0"
REVISI	ONS	
No.	Description	Date
-		-

Basement & 1st Floor Plans

# **Murdock Street**

50-54 Murdock Street, Somerville, MA

**Rob Grieco** 





17 IVALOO STREET SUITE 400 SOMERVILLE, MA 02143 TELEPHONE: 617-591-8682 FAX: 617-591-2086

COPYRIGHT KDI © 2017
THESE DRAWINGS ARE NOW AND DO
REMAIN THE SOLE PROPERTY OF KHALSA
DESIGN INC. USE OF THESE PLANS OR ANY
FORM OF REPRODUCTION OF THIS DESIGN
IN WHOLE OR IN PART WITHOUT EXPRESS
WRITTEN CONSENT IS PROHIBITED AND
SHALL RESULT IN THE FULLEST EXTENT OF
PROSECUTION UNDER LAW



	number	17107
Date		12/29/2017
Drawn b	ру	JSK
Checke	cked by Checke	
Scale		3/16" = 1'-0'
REVIS	SIONS	
NI -	Dan and attent	D-1-
No.	Description	Date

Roof Plans





#1

#3

MURDOCK ST.

2 Exterior Lighting Plan 1/8" = 1'-0"

#4

#6

#8

#13

#12

ALL DECKS ON EACH FLOOR TO HAVE WALL MOUNTED SCONES ON EACH SIDE OF THE DOOR #10



**Cold Weather Starting:** The minimum starting temperature is -30C. Green Technology: Mercury and UV free. RoHS compliant components.

Precision die cast aluminum housing, lens frame. RAB warrants that our LED products will be free from 42" Bollard. defects in materials and workmanship for a period of five (5) years from the date of delivery to the end user, High temperature silicone.

Finish: Anchor Bolt: 3-step MacAdam Ellipse binning to achieve consistent 
The anchor bolts for the BLED's have the following

including coverage of light output, color stability, driver performance and fixture finish. Formulated for high-durability and long lasting color. Equivalent to 70W Metal Halide. Buy American Act Compliance: RAB values USA manufacturing! Upon request, RAB may be able to manufacture this product to be compliant with the Buy American Act (BAA). Please contact customer service to request a quote for the product to be made BAA compliant. Multi-chip 13W high output long life LED Driver Constant Current, Class 2 100V - 277V, 50/60 Hz. BUG Rating:

B1 U0 G0

B1 U0 G0

BUG Rating:

One Light Outdoor Wall

Manufacturer: Minka

Width/Dia.: 8"

811530

71241-66

9.75"

Item ID:

MFG #:

Height:

Length:

Shipped Via:

Safety Rating: UL, cUL

**Wolfers Lighting** 

103 North Beacon Street

Website: www.wolfers.com

Allston, MA 02134

Safety Listing:

Fax: 617-746-5544 Email: internetsales@wolfers.com

Item ID:

MFG #:

Finish:

Height:

Length:

Please be advised that all prices and information shown here are subject to verification by our showroom personnel. In the event of a discrepancy, we reserve the right to make any corrections necessary.

Width/Dia.:

Manufacturer:



246149

8607-12

23.75"

5.75"

Source Watt CCT CRI Lm Avg. Life Dim Incl.

**Black Aluminum** 

**Adjustable Piedmont Swivel Flood** 

Residences

PROJECT ADDRESS

PROJECT NAME

50-54 Murdock Street, Somerville, MA

**Murdock Street** 

CLIENT

ARCHITECT

**Rob Grieco** 



17 IVALOO STREET SUITE 400 SOMERVILLE, MA 02143

TELEPHONE: 617-591-8682 FAX: 617-591-2086

CONSULTANTS:

**LED Outdoor Flushmount** Item ID: 053030

Manufacturer: Murray Feiss OL11313BK-MFG #: Finish: Black Height: **5.13**" Width/Dia.: 11.75"

	include the second	ueu						
Туре	Base	Source	Watt	ССТ	CRI	Lm	Avg. Life	Dir
	LED Integrated Module							
es		Ad	ditiona	l Infor	mation	1		
	CETL					Seed	ed	
	Type  res Rating:	Type Base  LED Integrated Module  res  Rating: cETL	LED Integrated Module  res Rating: cETL  Add Gla	Type Base Source Watt  LED Integrated Module  Pes Rating: cETL  Additiona Glass:	Type Base Source Watt CCT  LED Integrated Module  Pes Rating: cETL  Additional Information Glass:	Type Base Source Watt CCT CRI  LED Integrated Module  Pes Rating: CETL  Additional Information Glass: Clear	Type Base Source Watt CCT CRI Lm  LED Integrated Module  Pes Rating: cETL  Additional Information Glass: Clear Seed	Type Base Source Watt CCT CRI Lm Avg. Life  LED Integrated Module  Additional Information Glass: Clear Seeded

Phone: 617-254-0700

Email: internetsales@wolfers.com

Fax: 617-746-5544

Please be advised that all prices and information shown here are subject to verification by our showroom personnel. In the event of a discrepancy, we reserve the right to make any corrections necessary.

COPYRIGHT KDI © 2017 THESE DRAWINGS ARE NOW AND DO REMAIN THE SOLE PROPERTY OF KHALSA DESIGN INC. USE OF THESE PLANS OR ANY FORM OF REPRODUCTION OF THIS DESIGN IN WHOLE OR IN PART WITHOUT EXPRESS WRITTEN CONSENT IS PROHIBITED AND SHALL RESULT IN THE FULLEST EXTENT OF PROSECUTION UNDER LAW

REGISTRATION



Project nu	mber	17107	
Date		12/29/2017	
Drawn by		NB	
Checked I	ру	JSK	
Scale	ŀ	As indicated	
REVISION	ONS		
No.	Description	Date	

Proposed Exterior Lighting Plan & **Fixtures** 

Murdock Street Residences